

ABBREVIATIONS SYMBOLS ALTERNATING CURRENT, AIR CONDITIONING CIRCUIT BREAKER, RATING AS SHOWN. A, AMP **AMPERE** AMPERES FRAME AIR HANDLING UNIT TRANSFORMER - SIZED AS NOTED ON SCHEDULE. **AUTHORITY REPRESENTATIVE** SUBSCRIPT IS IDENTIFIER. m**AMPERES TRIP** AWG AMERICAN WIRE GAUGE JUNCTION BOX - CEILING MOUNTED TYPE (J) OR[J] **BRKR** BREAKER AS INDICATED OR AS REQUIRED BY CODE. CONDUIT C, CND CF CENTRIFUGAL FAN JUNCTION BOX - WALL MOUNTED. CHILLER CHW, CHWP, CHPCHILLED WATER PUMP CONTROL PANEL MOTOR CONNECTIONS, NUMBER IS HP. CT **COOLING TOWER** CTL CONTROL NON-FUSED SAFETY SWITCH, RATING AS SHOWN 8 □ **CWP** CONDENSER WATER PUMP (AMPACITY/POLES). **DWG DRAWING EXISTING** \boxtimes MAGNETIC STARTER, FVNR, SIZED AS REQUIRED. EXHAUST FAN EG **EQUIPMENT GROUND** EHC **ELECTRIC HEATING COIL** CONDUIT OR CABLE TURNING AWAY OR DOWN. ELEC **ELECTRICAL ELEV ELEVATOR** CONDUIT OR CABLE TURNING UPWARD OR TOWARDS EM **EMERGENCYZ** VIEWER. EUH ELECTRIC UNIT HEATER **EXIST EXISTING** CONDUIT OR CABLE EXPOSED. FCU FAN COIL UNIT FLA FULL LOAD AMPERES G, GND GROUND CONDUIT RUN CONCEALED. GFP GROUND FAULT PROTECTION GRS GALVANIZED RIGID STEEL HOMERUN TO DISTRIBUTION EQUIPMENT. EQUIPMENT HORSE POWER, HEAT PUMP GROUND WIRE SHALL BE PROVIDED FOR ALL HEATER CIRCUITS. HEATING, VENTILATING, AIR CONDITIONING **HVAC** MINIMUM 3/4"C AND #12 WIRING. HERTZ INSTANTANEOUS WATER HEATER ELECTRICAL EQUIPMENT, TYPE AS INDICATED. JB JUNCTION BOX **KCMIL** THOUSAND CIRCULAR-MIL PANELBOARD, DISTRIBUTION AND LIGHTING, 480/277V. KILO-VOLT AMPERE **KILOWATT** LTFC LIQUIDTIGHT FLEXIBLE CONDUIT PANELBOARD, LIGHTING AND APPLIANCE, 208/120V. LIGHTING LTS LIGHTS VARIABLE FREQUENCY DRIVE (VFD). MACH MACHINE MOTORIZED DAMPER **MEZZANINE** SINGLE POLE SWITCH, +48 AFF U.O.N MCA MAXIMUM CIRCUIT AMPACITY LETTER INDICATES FIXTURES CONTROLLED. MCC MOTOR CONTROL CENTER MCOP, MOP MINIMUM OVER-CURRENT PROTECTION 4' SURFACE-MOUNTED FLUORESCENT STRIP LIGHT MFR MANUFACTURER LETTER INDICATES CONTROLLING SWITCH. **MECH** MECHANICAL MLO MAIN LUG ONLY 4' SURFACE-MOUNTED FLUORESCENT STRIP **NEMA** NATIONAL ELECTRICAL MANUFACTURERS ASSOCIATION EMERGENCY LIGHT. **#,** NO. **NUMBER** POLE 4' SURFACE-MOUNTED FLUORESCENT STRIP LIGHT PASS **PASSAGEWAY** ┝╼╌┤ FOR DEMOLITION. ø,PH **PHASE** PLT **PLANT** PNL PANEL KEYED NOTE FOR DEMOLITION PLAN. **PWR POWER** QUANTITY KEYED NOTE FOR NEW WORK PLAN. **RECPT** RECEPTACLE RLA RUNNING LOAD AMPERES \mathcal{T} ROOM EMERGENCY STOP PUSH BUTTON. RMS ROOT MEAN SQUARE **SWBD SWITCHBOARD** WORK TO BE REMOVED. SHOWN DOTTED. TYP TYPICAL UH UNIT HEATER UL UNDERWRITERS LABORATORIES UON UNLESS OTHERWISE NOTED VFD VARIABLE FREQUENCY DRIVE **XFMR** TRANSFORMER

REFERENCE DRAWINGS

DESIGNED B.IDILBI

CHECKED D. KHAN

DRAWN


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GENERAL NOTES


- 1. REFER TO DRAWING NO. G-002 FOR INDEX OF DRAWINGS.
- 2. THE CONTRACTOR SHALL VERIFY ALL DIMENSIONS IN THE FIELD AND SHALL REPORT DISCREPANCIES, IF ANY, TO THE AUTHORITY REPRESENTATIVE (AR) FOR CLARIFICATION, PRIOR TO STARTING ANY WORK. THE DRAWINGS ARE INTENDED TO INDICATE THE EXTENT OF THE WORK DIAGRAMMATICALLY
- 3. THE CONTRACTOR SHALL VISIT THE SITE AND FAMILIARIZE THEMSELVES WITH ALL VISIBLE EXISTING CONDITIONS, IN PARTICULAR ACCESSIBILITY INTO EACH OF THE EQUIPMENT ROOMS FOR THE REMOVAL AND DELIVERY OF EQUIPMENT.
- 4. EXACT LOCATION OF ALL EQUIPMENT AND ACCESSORIES SHALL BE VERIFIED IN THE FIELD.
- 5. IDENTIFY ALL ITEMS TO BE DEMOLISHED. DEMOLISHED ITEMS SHALL BE REMOVED AND PROPERLY DISPOSED OFF SITE. NO ITEMS SHALL BE CAP AND ABANDON ON SITE.
- 6. ALL SURFACES DAMAGED IN THE COURSE OF THE WORK SHALL BE RESTORED TO THE ORIGINAL CONDITION TO THE COMPLETE SATISFACTION OF THE AR.
- 7. ALL WORK SHALL BE COORDINATED WITH EXISTING SERVICES AND OTHER TRADES DURING INSTALLATION.
- 8. ALL EXISTING LIGHTING FIXTURES THAT ARE IN THE WAY OF THE DEMO WORK SHALL BE REMOVED AND REINSTALLED AFTER NEW WORK IS DONE. THIS NOTE IS ALSO APPLICABLE TO OTHER EQUIPMENT THAT POSES AN OBSTRUCTION.
- 9. SCALE ON THE DRAWINGS IS APPROXIMATE. THE CONTRACTOR IS RESPONSIBLE FOR ALL FIELD MEASUREMENTS.
- 10. THE CONTRACTOR SHALL VERIFY THE LOCATION OF ALL EXISTING ELECTRICAL AND MECHANICAL WORK, PROVIDE CLEARANCE FOR MAINTENANCE BETWEEN EXISTING EQUIPMENT AND NEW WORK ALSO, COORDINATE WITH THE ELECTRICAL DRAWINGS.
- 11. THE EQUIPMENT NAMES/NUMBERS FOR THIS DESIGN ARE THE SAME AS IN THE ORIGINAL DESIGN. THIS IS DONE TO AVOID ANY CONFUSION FOR THE MAINTENANCE AND THE FILING SYSTEM. IN
- 12. PERFORM WORK AND PROVIDE MATERIALS AND EQUIPMENT AS SHOWN ON DRAWINGS. COORDINATE ELECTRICAL WORK WITH WORK OF OTHER TRADES.
- 13. MATERIAL AND EQUIPMENT SHALL BE NEW AND UL APPROVED AND SHALL MEET NEMA, ANSI, IEEE & NEC REQUIREMENTS FOR INTENDED SERVICE. MATERIAL AND INSTALLATION SHALL MEET REQUIREMENTS OF NATIONAL AND LOCAL ELECTRICAL CODES.
- 14. MAINTAIN RECORD DRAWINGS ON SITE. RECORD SET MUST BE COMPLETE AND CURRENT AND AVAILABLE FOR INSPECTION WHEN REQUISITIONS FOR PAYMENT ARE SUBMITTED.
- 15. GUARANTEE WORK IN WRITING FOR ONE YEAR FROM DATE OF FINAL ACCEPTANCE. REPAIR OR REPLACE DEFECTIVE MATERIALS OR INSTALLATION AT NO COST TO THE AUTHORITY. CORRECT DAMAGE CAUSED IN MAKING NECESSARY REPAIRS AND REPLACEMENTS UNDER GUARANTEE AT NO COST TO THE AUTHORITY.
- 16. STATEMENT OF GUARANTEE REQUIREMENTS SHALL NOT BE INTERPRETED TO LIMIT AUTHORITY'S RIGHTS UNDER LAW AND THIS CONTRACT.
- 17. DRAWINGS ARE DIAGRAMMATIC AND INDICATE GENERAL ARRANGEMENT OF SYSTEMS.
- 18. TEMPORARY LIGHT AND POWER SHALL BE PROVIDED ON SITE BY THE CONTRACTOR.
- 19. SUBMIT SHOP DRAWINGS AND PRODUCT DATA WITHIN 30 DAYS AFTER AWARD OF CONTRACT. CHECK. STAMP AND MARK SUBMITTALS WITH PROJECT NAMES BEFORE TRANSMITTING TO ENGINEER, INDICATE DEVIATIONS FROM CONTRACT DOCUMENTS. SHOP DRAWINGS SHALL BE PROVIDED FOR ALL EQUIPMENT SHOWN ON THE DRAWINGS.
- 20. DEVIATION FROM CONTRACT DOCUMENTS, OR PROPOSED SUBSTITUTION OF MATERIALS OR EQUIPMENT FOR THOSE SPECIFIED, SHALL BE REQUESTED IN SEPARATE LETTER, WHETHER DEVIATIONS ARE DUE TO FIELD CONDITIONS, STANDARD SHOP PRACTICE, OR OTHER CAUSE
- 21. ALL WIRING SHALL BE RUN CONCEALED IN FINISHED AREAS AND EXPOSED IN UNFINISHED AREAS.
- 22. ALL GROUNDING SHALL BE PERFORMED IN ACCORDANCE WITH WMATA SPECIFICATION AND THE NATIONAL AND LOCAL ELECTRICAL CODES.
- 23. NEW CIRCUIT BREAKER RATING SHALL BE COMPARABLE WITH EXISTING PANELBOARD CIRCUIT BREAKERS AND AIC RATINGS.
- 24. AT LOCATIONS WHERE NEW CONDUITS AND CABLES EXIT MECHANICAL AND/OR AC SWITCHBOARD ROOMS, THE CONTRACTOR SHALL PROVIDE DRILLED HOLES IN CONCRETE FLOORS AND WALLS AS REQUIRED. EXISTING CONDUIT SLEEVES MAY BE USED FOR THIS PURPOSE IF AVAILABLE.
- 25. CONDUIT SIZE AND CABLE SIZE/TYPE INDICATED ON DRAWINGS ARE APPLICABLE TO ENTIRE LENGTH OF BRANCH CIRCUIT UNLESS OTHERWISE NOTED.
- 26. EXISTING CONDUITS ASSOCIATED WITH NEW ACU/FAN WORK THAT ARE NOT REUSED SHALL BE REMOVED, PROVIDED THAT THEY DO NOT CONTAIN ACTIVE CIRCUITS/WIRING FOR PROJECT WORK AND/OR EXISTING ADJACENT EQUIPMENT THAT IS NOT IN CONTRACT.
- 27. EXPOSED CONDUITS SHALL BE GALVANIZED RIGID STEEL TYPE.
- 28. ALL WIRING SHALL BE UL LISTED TYPE RHW-2, LOW SMOKE ZERO HALOGEN.
- 29. INSULATION RESISTANCE TEST SHALL BE PERFORMED ON ALL NEW AND REUSED CABLES. IF

RESISTANCE FOR REUSED CABLE FAILS, THE CABLE SHALL BE REMOVED AND REPLACED WITH A NEW CABLE.

30. ALL NEW AND REUSED CONDUITS, CABLES AND ELECTRICAL DEVICES ARE TO BE LABELED AS PER WMATA SPECIFICATIONS.

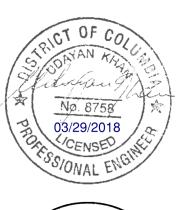

UDAYAN KHAN Lic. No. 024656 03/29/2018

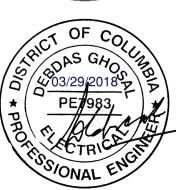





State of Maryland Professional Certification. I hereby certify that these documents were prepared or approved by me, and that I am a duly licensed professional engineer under the laws of the State of Maryland, License No. 024687, Expiration Date: 03/15/2020





REPLACEMENT OF CHILLERS

AND COOLING TOWER ACCESSORIES AT EIGHT METRO-RAIL STATIONS

State of Maryland Professional Certification. I hereby certify that these documents were prepared or approved by me, and that I am a duly licensed professional engineer under the laws of the State of Maryland, License No. 030273, Expiration Date: 05/18/2018


WASHINGTON METROPOLITAN AREA TRANSIT AUTHORITY DATE NUM DESCRIPTION TITLE NUMBER 03/30/2018 0 FINAL CONTRACT DRAWINGS DEPARTMENT OF DESIGN AND CONSTRUCTION SERVICES


REVISIONS

OFFICE OF INFRASTRUCTURE RENEWAL PROGRAM GROUP

21 Magnusser 03/2018 MARK MAGŇUSSEN DATE **GRAHAM SPILLER** MANAGER, ENV. PLANNING AND COMP GFP DEPUTY PROGRAM MANAGER

ELECTRICAL SYMBOLS AND ABBREVIATIONS M NO. CONTRACT NO. SCALE DRAWING NO. SHEET NO. M1304 FQ-18102 NONE E-001 09 of 173

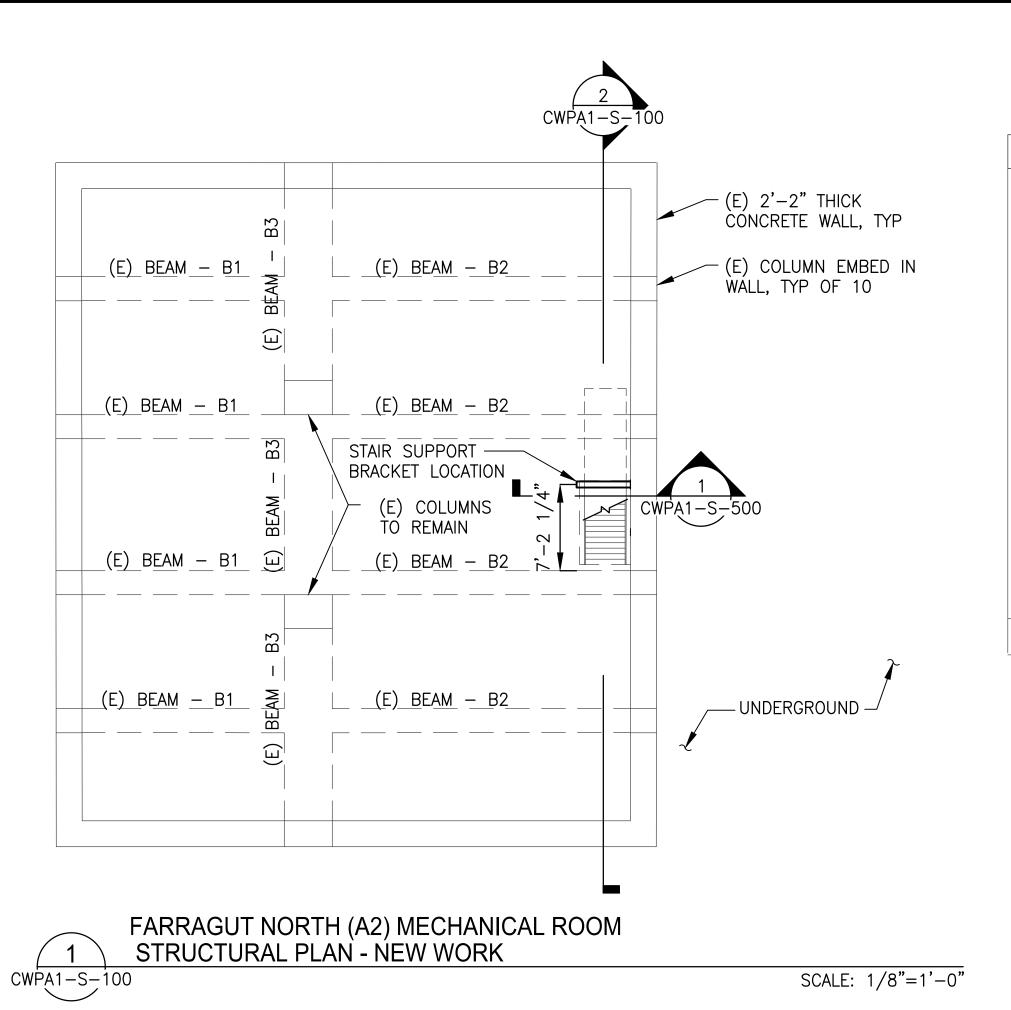

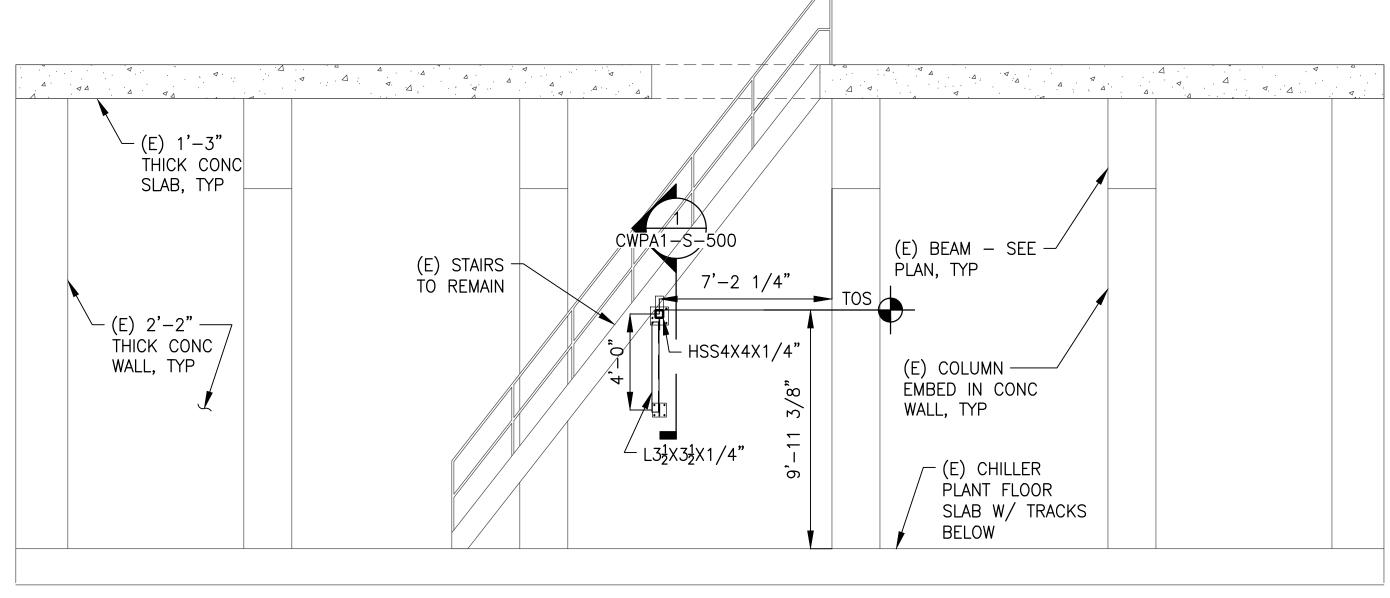

NOTES:

SCALE: 1/4"=1'-0"


- 1. EXISTING STEEL STAIR IS TO REMAIN DURING INSTALLATION OF SUPPORT.
- 2. FIELD VERIFY ALL EXISTING CONDITIONS AND DIMENSIONS BEFORE STARTING CONSTRUCTION AND/OR SUBMITTING SHOP DRAWINGS. ANY DISCREPANCIES SHALL BE REPORTED TO THE WMATA. ALL EXISTING INFORMATION IS BASED ON SITE VISITS AND EXISTING DRAWINGS BY KCE STRUCTURAL ENGINEERS P.C. DATED AUGUST 13, 1976.
- 3. EXISTING CONCRETE SHALL BE SCANNED WITH GROUND PENETRATING RADAR (GPR) AT ALL AREAS WHERE ANCHORAGE IS MADE TO EXISTING CONCRETE. NO EXISTING REINFORCING SHALL BE CUT.



LEUTERIO THOMAS LLC ARCHITECTS + ENGINEERS 6710 Oxon Hill Road, Suite 310 National Harbor, MD 20745



A Gannett Fleming/Parsons
JOINT VENTURE

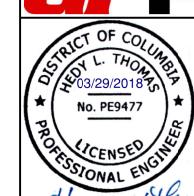

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WASHINGTON METROPOLITAN AREA TRANSIT AUTHORITY

DEPARTMENT OF DESIGN AND CONSTRUCTION SERVICES OFFICE OF INFRASTRUCTURE RENEWAL PROGRAM GROUP

MANAGER, ENV. PLANNING AND COMP


SECTION

CWPA1-S-100

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	GRAHAM SPILL GFP DEPUTY P	ER ROGRAM MANAGER	DATE	M

REPLACÉMENT OF CHILLERS AND COOLING TOWER ACCESSORIES AT EIGHT METRO-RAIL STATIONS CWPA1 - FARRAGUT NORTH (A2) STRUCTURAL PLAN- NEW WORK


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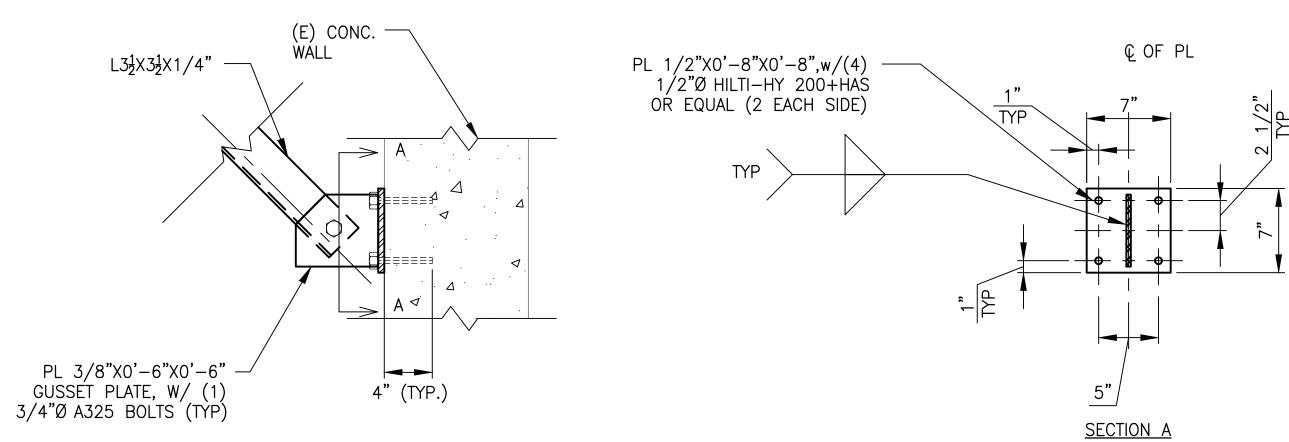
(E) CONC. — WALL Ç OF BEAM HSS4X4 — 4" (TYP.) — PL 1/2"X0'-9"X0'-9", w/(4) -1/2"Ø HILTI-HY 200+HAS OR EQUAL (2 EACH SIDE) SECTION A

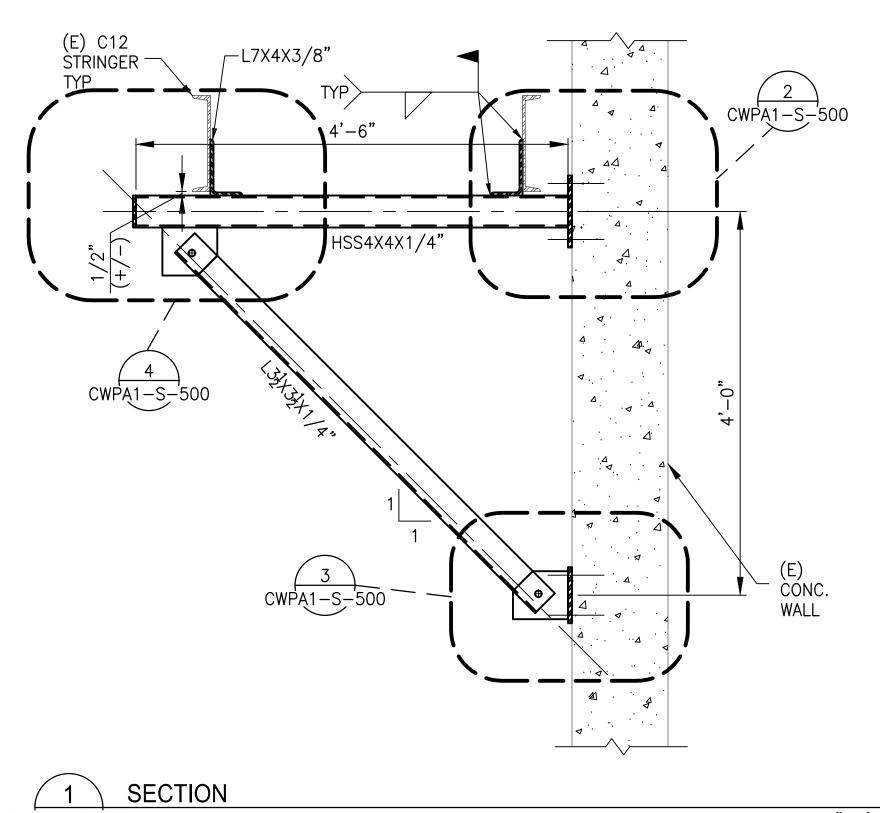NOTE: EXISTING CONCRETE SHALL BE SCANNED WITH GROUND PENETRATING RADAR (GPR) AT ALL AREAS WHERE ANCHORAGE IS MADE TO EXISTING CONCRETE. NO EXISTING REINFORCING SHALL BE CUT.

DETAIL 1 SCALE: 1-1/2"=1'-0"CWPA1-S-500




SCALE: 1"=1'-0"

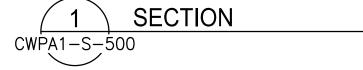

NOTE: EXISTING CONCRETE SHALL BE SCANNED WITH GROUND PENETRATING RADAR (GPR) AT ALL AREAS WHERE ANCHORAGE IS MADE TO EXISTING CONCRETE. NO EXISTING REINFORCING SHALL BE CUT.

DETAIL 2 CWPA1-S-500

SCALE: 1-1/2"=1'-0"

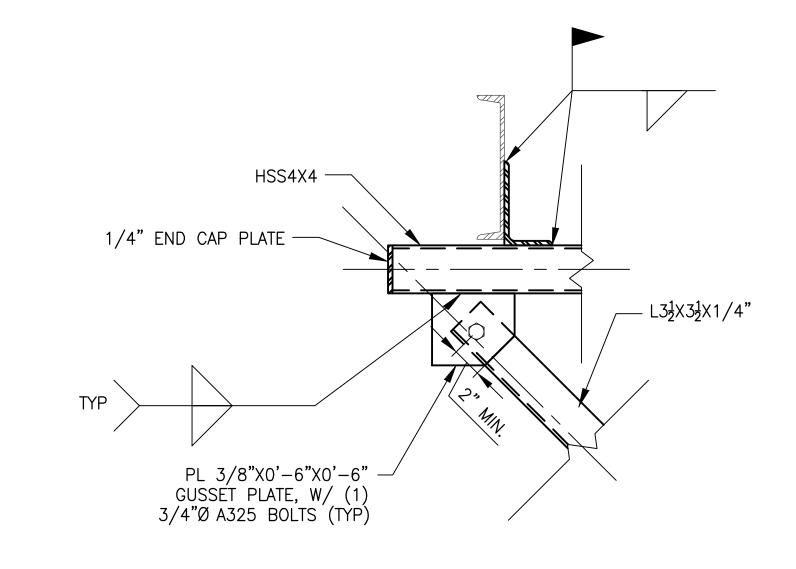


DETAIL 3 CWPA1-S-500 SCALE: 1-1/2"=1'-0"



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			REFERENCE DRAWINGS			REVISIONS	
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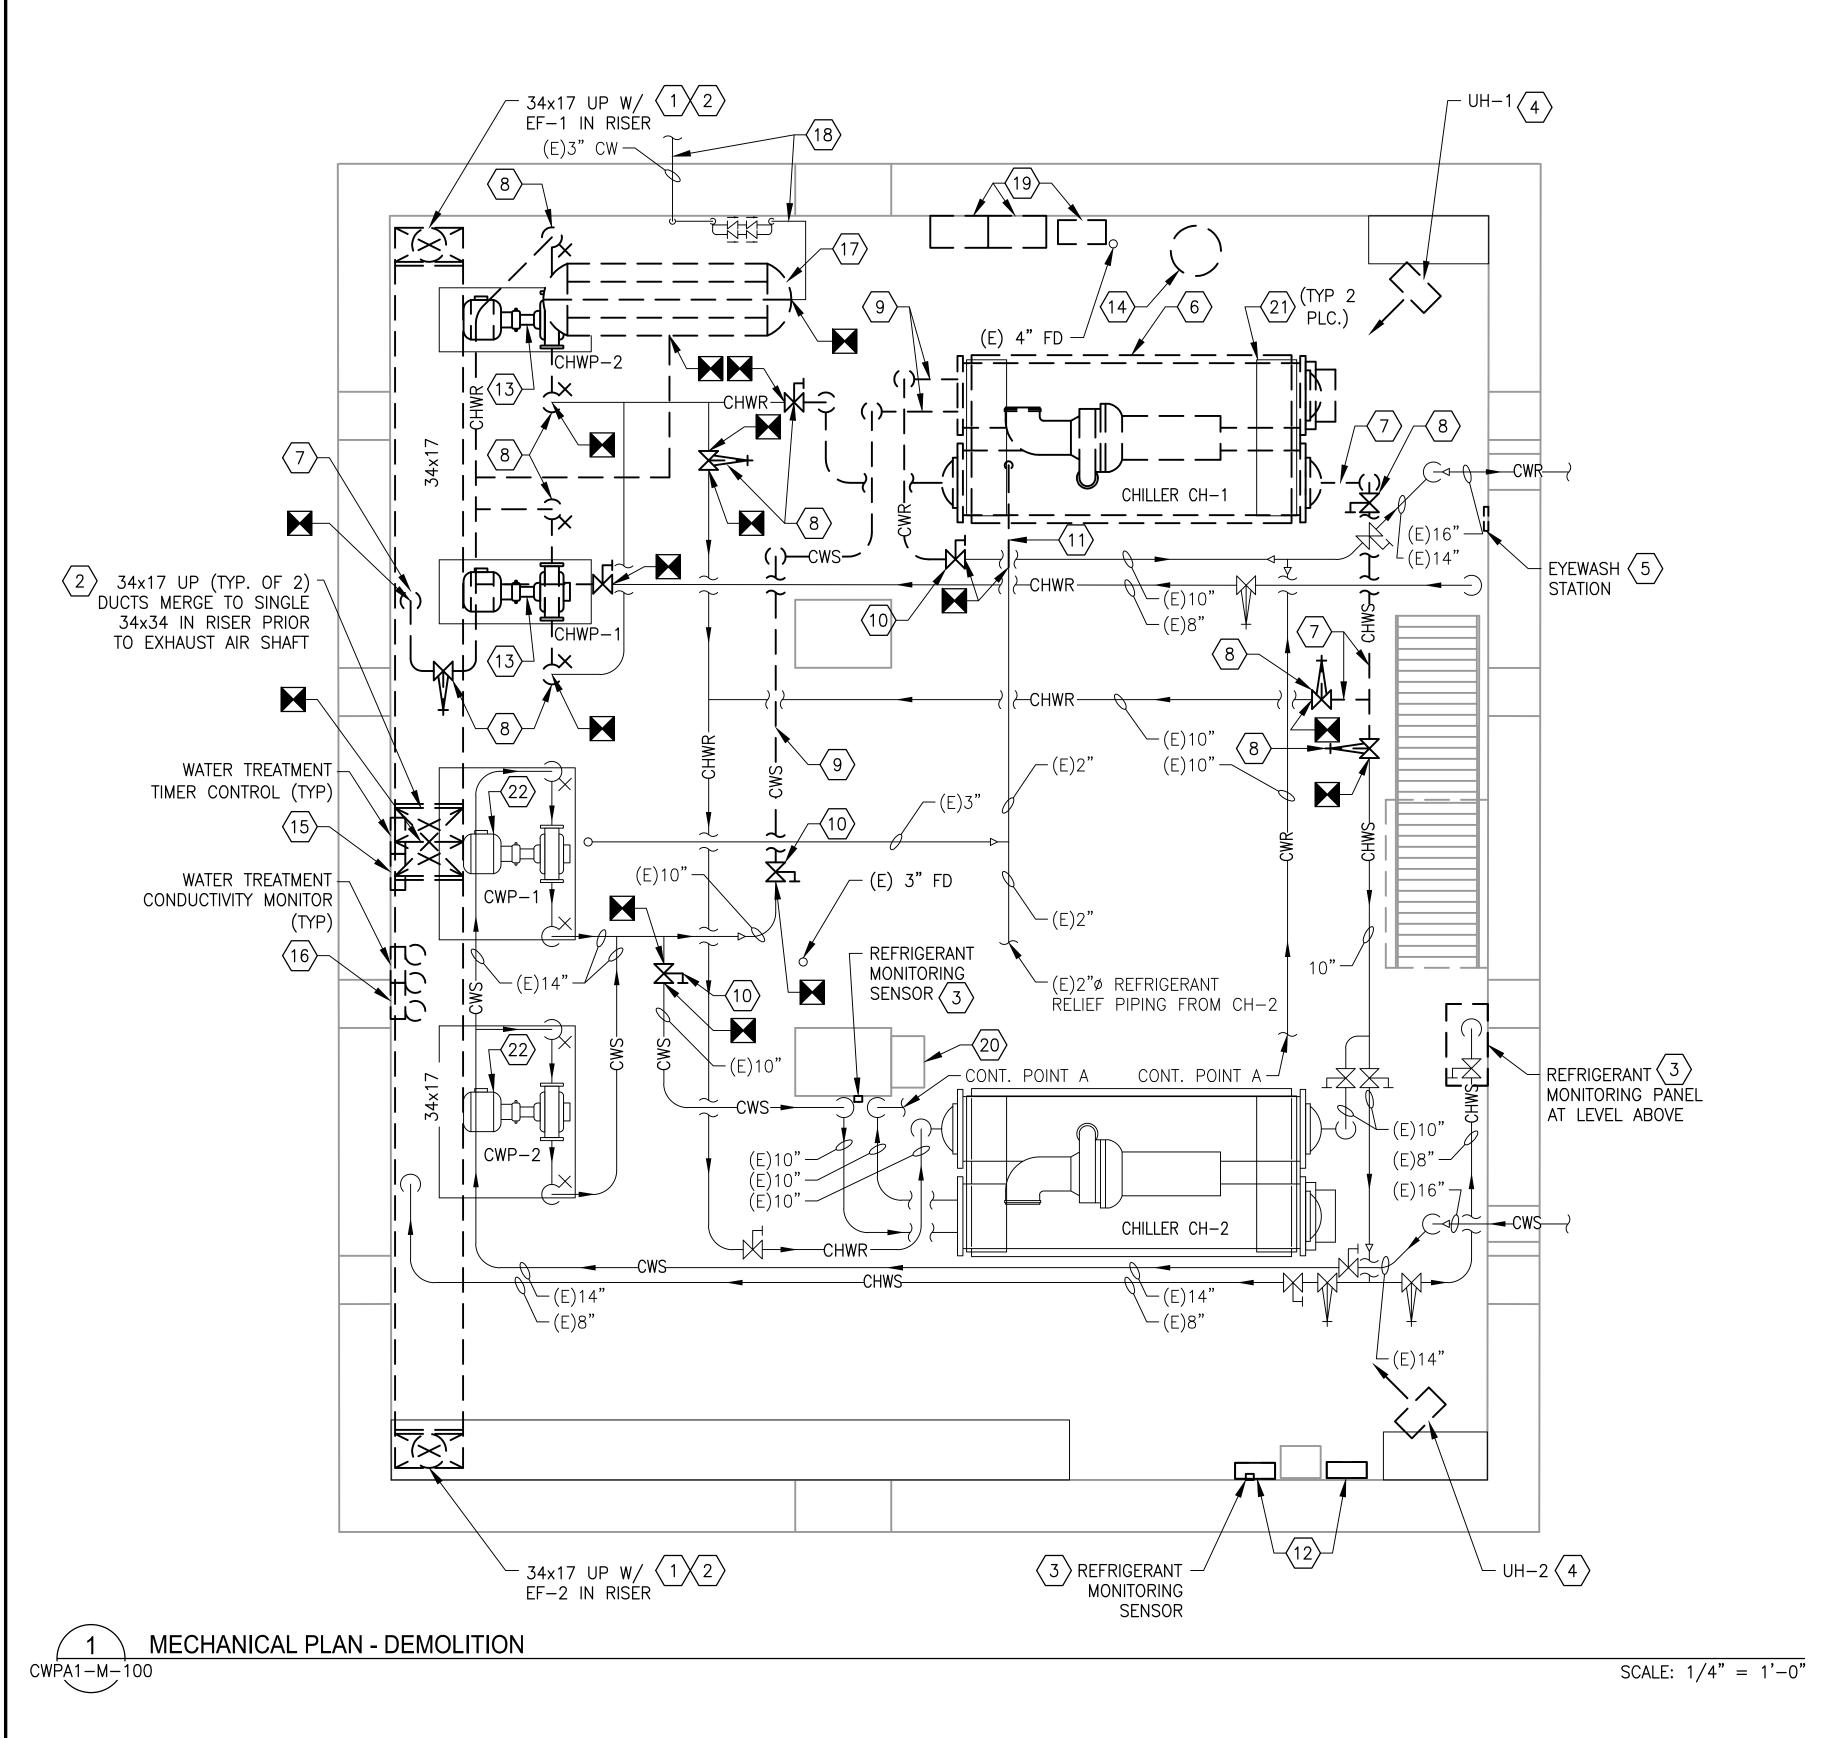
WASHINGTON METROPOLITAN AREA TRANSIT AUTHORITY

DEPARTMENT OF DESIGN AND CONSTRUCTION SERVICES OFFICE OF INFRASTRUCTURE RENEWAL PROGRAM GROUP

03/2018 GRAHAM SPILLER
GFP DEPUTY PROGRAM MANAGER MANAGER, ENV. PLANNING AND COMP

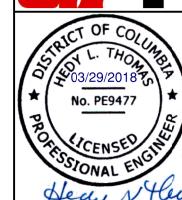REPLACÉMENT OF CHILLERS
AND COOLING TOWER ACCESSORIES AT EIGHT METRO-RAIL STATIONS
CWPA1 - FARRAGUT NORTH (A2)
STRUCTURAL DETAILS .

STRUCTURAL DETAILS							
M NO.	CONTRACT NO.	SCALE	DRAWING NO.	SHEET NO.			
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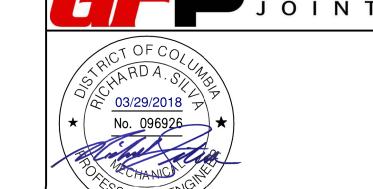
GENERAL NOTES:

- A. CONTRACTOR SHALL FIELD VERIFY EXACT LOCATION AND QUANTITIES OF EQUIPMENT, PIPING, VALVES, DUCTWORK, ELECTRICAL AND CONTROL WIRING PRIOR TO DEMOLITION. ITEMS SHOWN ON THIS PLAN ARE APPROXIMATE.
- B. REFER TO LEGEND SHEET FOR GENERAL ABBREVIATIONS AND SYMBOLS.

KEYNOTES:

- $\langle 1 \rangle$ REMOVE AND DISPOSE OF EXHAUST FANS EF-1 AND EF-2, INCLUDING FAN MOTORS, SUPPORTS, WIRING, AND OTHER RELATED ACCESSORIES.
- REMOVE AND DISPOSE OF DUCTWORK, INCLUDING DUCT FITTINGS. DUCT SUPPORTS. GRILLES AND SCREENS. DAMPERS, AND OTHER RELATED ACCESSORIES AS INDICATED. DEMOLITION SHALL BE UP TO POINT OF DUCTWORK CONNECTION TO EXHAUST AIR SHAFT.
- (3) REMOVE AND DISPOSE OF REFRIGERANT MONITORING SENSORS AND PANEL, INCLUDING ALL TUBING, WIRING, CONDUIT, JUNCTION AND PULL BOXES, AND DEVICES. REFRIGERANT MONITORING PANEL IS LOCATED AT THE INTERMEDIATE PLANT ENTRANCE STAIR LANDING (NOT SHOWN ON DRAWINGS).
- 4 REMOVE AND DISPOSE OF UNIT HEATERS UH-1 AND UH-2, INCLUDING SUPPORTS, WIRING, CONDUIT JUNCTION AND PULL BOXES, AND ANY ASSOCIATED THERMOSTATS.
- 5 REMOVE AND DISPOSE OF EXISTING WALL-MOUNTED EYEWASH STATION.
- (6) REMOVE AND DISPOSE OF CHILLER CH-1, CHILLER SUPPORT, STARTER, WIRING, CONDUIT, JUNCTION AND PULL BOXES, DISCONNECT, AEMS SENSORS, AND CONTROLS. REMOVAL SHALL INCLUDE R-134a EVACUATION BY A CERTIFIED COMPANY. RECOVERED REFRIGERANT SHALL BE CLEANED AND RETURNED TO WMATA PLANT MAINTENANCE IN 125 POUND BULLET CONTAINERS.
- 7 REMOVE AND DISPOSE OF CHILLED WATER PIPING (CHWS, CHWR), INSULATION, SUPPORT, TEMPERATURE AND PRESSURE GAUGES. EXTENT OF PIPING REMOVAL SHALL BE, IN GENERAL, TO THE FIRST ISOLATION VALVE FLANGE AFTER THE VALVE. EXACT DEMOLITION POINT SHALL BE FIELD COORDINATED BY CONTRACTOR TO ACCOMMODATE NEW PIPING CONNECTIONS.
- (8) REMOVE AND DISPOSE OF CHILLED WATER PIPING VALVES AS IDENTIFIED ON PLANS. EXACT QUANTITY OF VALVES SHALL BE VERIFIED BY INSTALLING CONTRACTOR. THE EXTENT OF ALL VALVE REPLACEMENTS SHALL BE INCLUSIVE OF THE VALVE CONNECTION FLANGES.
- 9 REMOVE AND DISPOSE OF CONDENSER WATER PIPING (CWR, CWS), TEMPERATURE AND PRESSURE GAUGES. EXTENT OF PIPING REMOVAL SHALL BE, IN GENERAL, TO THE FIRST ISOLATION VALVE FLANGE AFTER THE VALVE. EXACT DEMOLITION POINT SHALL BE FIELD COORDINATED BY CONTRACTOR TO ACCOMMODATE NEW PIPING CONNECTIONS.
- (10) REMOVE AND DISPOSE OF CONDENSER WATER PIPING VALVES AS IDENTIFIED ON PLANS. EXACT QUANTITY OF VALVES SHALL BE FIELD VERIFIED BY INSTALLING CONTRACTOR. THE EXTENT OF ALL VALVE REPLACEMENTS SHALL BE INCLUSIVE OF THE CONNECTION FLANGES.
- $\langle 11 \rangle$ REMOVE EXISTING 2"Ø REFRIGERANT RELIEF (VENT) PIPING TO EXTENT SHOWN.
- (12) REMOVE AND DISPOSE OF ABANDONED JOHNSON CONTROLS CHILLER CONTROL PANEL.

- (13) REMOVE AND DISPOSE OF CHILLED WATER PUMPS, CHWP-1 AND CHWP-2. REMOVAL SHALL INCLUDE PUMP, MOTOR, CONTROL AND POWER WIRING, CONDUIT, JUNCTION AND PULL BOXES, PIPING, SUPPORTS ISOLATION VALVES, STRAINERS, AND CHECK VALVES, WITH ALL INSTRUMENTATION AND CONTROLS. EXISTING EQUIPMENT PAD SHALL REMAIN AND BE RE-USED. EXTENT OF PIPING REMOVAL SHALL BE, IN GENERAL, TO THE INDICATED ISOLATION VALVE FLANGE FROM THE PUMPS. EXACT DEMOLITION POINT SHALL BE FIELD COORDINATED BY CONTRACTOR TO ACCOMMODATE NEW PIPING CONNECTIONS.
- (14) REMOVE AND DISPOSE OF CHEMICAL POT FEEDER AND ACCESSORIES FOR CHILLED WATER AND CONDENSER WATER SYSTEM.
- (15) REMOVE AND DISPOSE OF EXISTING CONDENSER WATER TREATMENT SYSTEM INCLUDING VALVES, PIPING, SUPPORTS, CHEMICAL DRUMS, METERING PUMPS, AND RELATED ELECTRICAL/CONTROL ACCESSORIES.
- (16) REMOVE AND DISPOSE OF EXISTING CONDUCTIVITY MONITORS.
- $\langle 17
 angle$ REMOVE AND DISPOSE OF EXISTING EXPANSION TANK, ASSOCIATED PIPING, AND VALVES. TANK SUPPORTS SHALL BE RE-USED.
- (18) EXISTING DOMESTIC CW INLET PIPING, INCLUDING BACKFLOW PREVENTER, VALVES, AND HOSE REEL TO REMAIN.
- (19) REMOVE AND DISPOSE OF ABANDONED CONDENSER WATER TREATMENT SYSTEM AND ALL ASSOCIATED PIPING, PUMPS, AND VALVES.
- (20) EXISTING AEMS PANEL AND DTS PANEL TO REMAIN.
- 21) CHILLER CONCRETE BASE PAD TO REMAIN AND BE RE-USED.
- (22) REMOVE AND DISPOSE OF EXISTING MOTOR ON CONDENSER WATER PUMPS CWP-1 AND CWP-2. REFER TO ELECTRICAL DRAWINGS FOR FURTHER INFORMATION.



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				REFERENCE DRAWINGS			REVISIONS	
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WASHINGTON METROPOLITAN AREA TRANSIT AUTHORITY


DEPARTMENT OF DESIGN AND CONSTRUCTION SERVICES OFFICE OF INFRASTRUCTURE RENEWAL PROGRAM GROUP

H Magnuser MARK MAGŇUSSEN MANAGER, ENV. PLANNING AND COMP

03/2018 DATE GRAHAM SPILLER GFP DEPUTY PROGRAM MANAGER

REPLACEMENT OF CHILLERS AND COOLING TOWER ACCESSORIES AT EIGHT METRO-RAIL STATIONS CWPA1 - FARRAGUT NORTH (A02) **MECHANICAL PLAN - DEMOLITION**

M NO. CONTRACT NO. SCALE DRAWING NO. SHEET NO. M1304 FQ-18102 1/4" = 1'-0" CWPA1-M-100 12 of 173

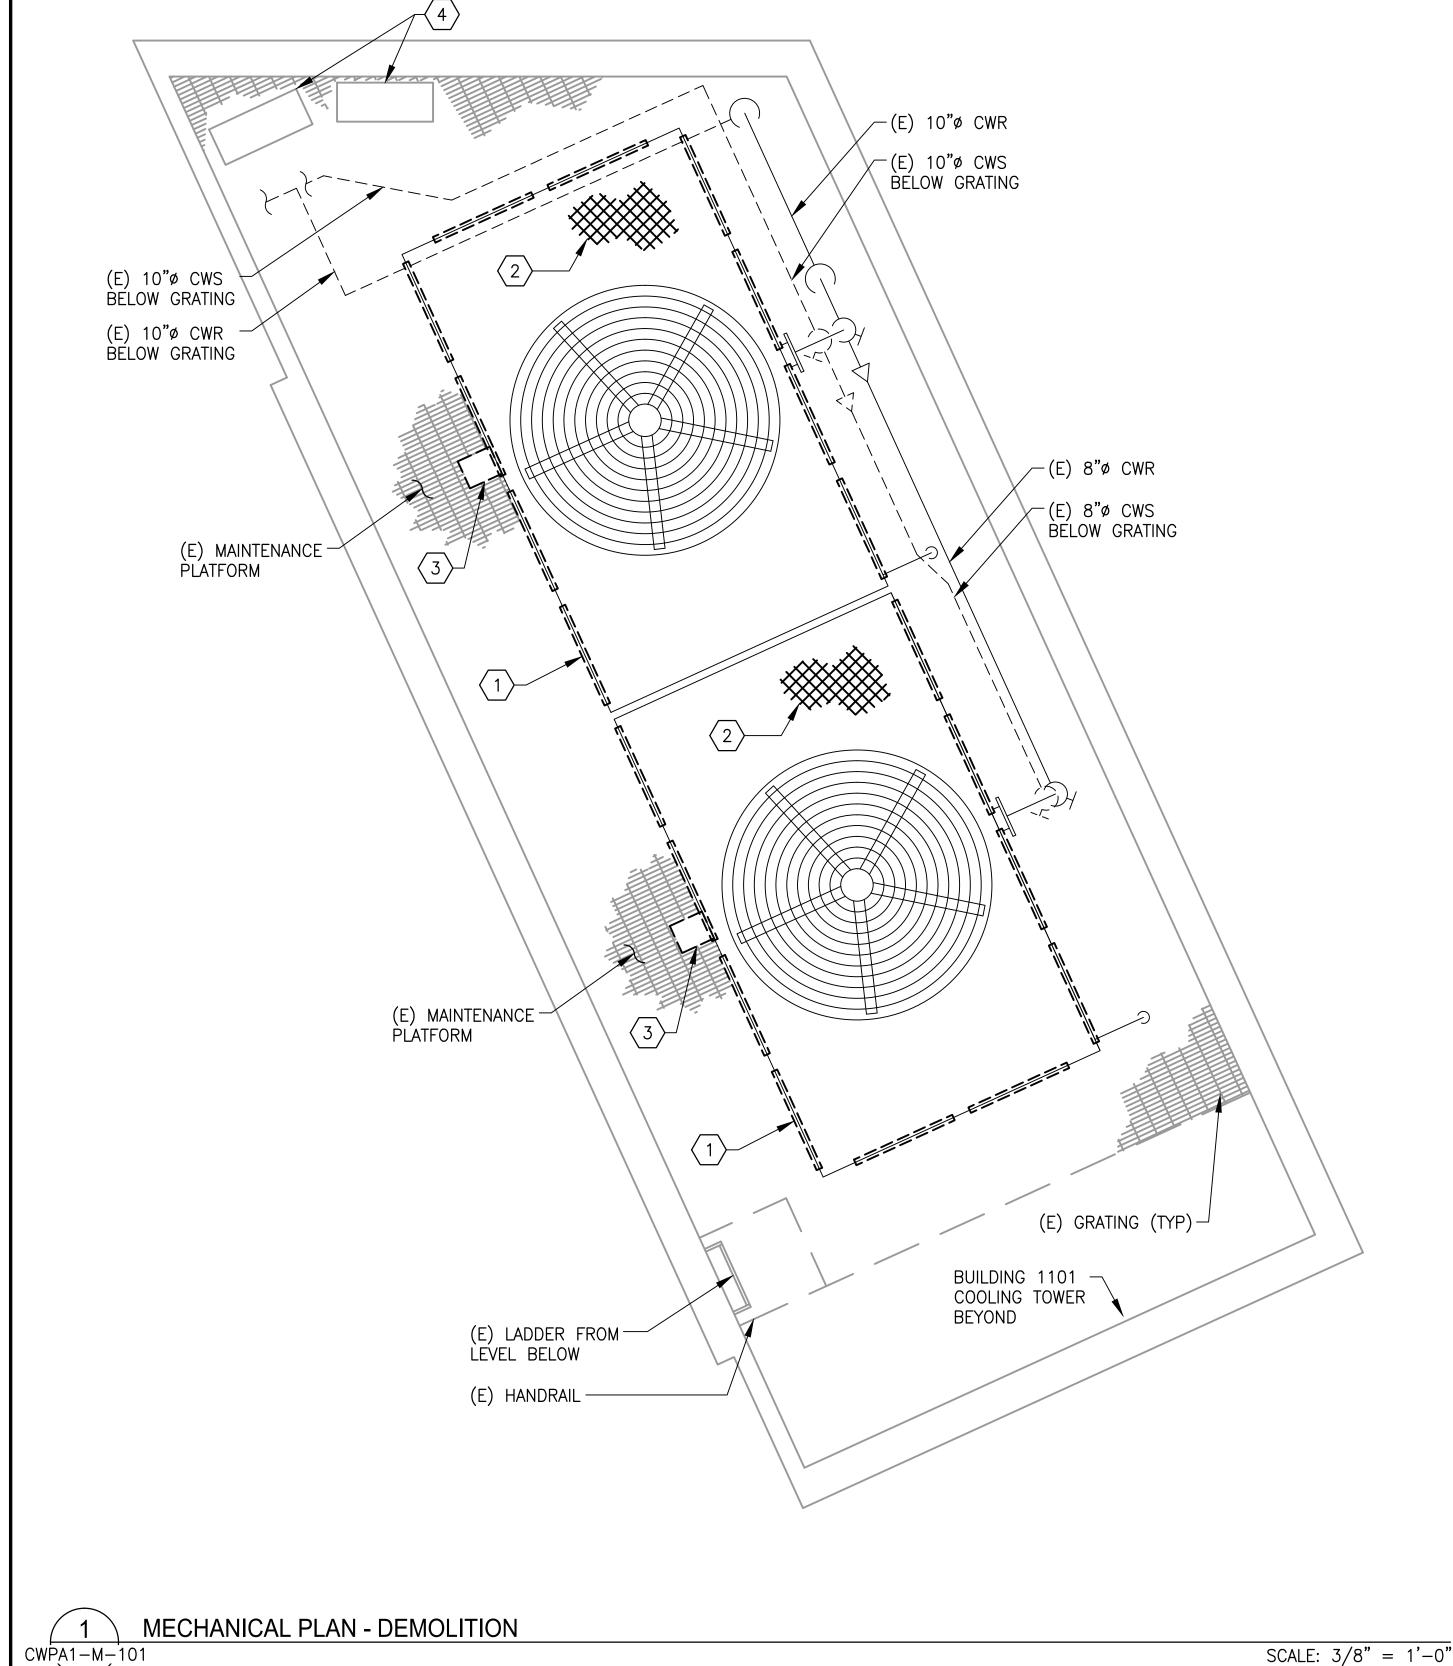

GENERAL NOTES:

- A. CONTRACTOR SHALL FIELD VERIFY EXACT LOCATION AND QUANTITIES OF EQUIPMENT, PIPING, VALVES, DUCTWORK, ELECTRICAL AND CONTROL WIRING PRIOR TO DEMOLITION. ITEMS SHOWN ON THIS PLAN ARE APPROXIMATE.
- B. REFER TO LEGEND SHEET FOR GENERAL ABBREVIATIONS AND SYMBOLS.
- C. COOLING TOWER IS LOCATED ON THE PENTHOUSE LEVEL OF BUILDING 1101 CONNECTICUT AVENUE NW, WASHINGTON, DC.
- D. ALL COOLING TOWER COMPONENTS THAT ARE REMOVED ARE TO BE REPLACED IN KIND. INSTALLING CONTRACTOR SHALL COORDINATE WITH COOLING TOWER MANUFACTURER PRIOR TO REMOVAL.

KEYNOTES:

- 1 REMOVE AND DISPOSE OF EXISTING LOUVER ON COOLING TOWER.
- 2 REMOVE AND DISPOSE OF EXISTING FILL IN THE COOLING TOWER.
- 3 REMOVE AND SALVAGE EXISTING FAN MOTOR, BELT DRIVEN FAN DRIVE ASSEMBLY, BELTS, SHEAVES, AND MOUNTING HARDWARE. RETURN ALL SALVAGED MATERIALS TO THE AR.
- 4 REMOVE AND DISPOSE OF EXISTING COOLING TOWER FAN CONTROLLER, VFD, AND DISCONNECT.

A Gannett Fleming/Parsons
JOINT VENTURE

03/29/2018

SCALE: 3/8" = 1'-0"

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WASHINGTON METROPOLITAN AREA TRANSIT AUTHORITY


DEPARTMENT OF DESIGN AND CONSTRUCTION SERVICES OFFICE OF INFRASTRUCTURE RENEWAL PROGRAM GROUP

GRAHAM SPILLER MANAGER, ENV. PLANNING AND COMP

03/2018 GFP DEPUTY PROGRAM MANAGER

REPLACEMENT OF CHILLERS AND COOLING TOWER ACCESSORIES AT EIGHT METRO-RAIL STATIONS CWPA1 - FARRAGUT NORTH (A02) MECHANICAL PLAN - DEMOLITION

CONTRACT NO. DRAWING NO. SHEET NO. M NO. SCALE M1304 3/8" = 1'-0" FQ-18102 CWPA1-M-101 13 of 173

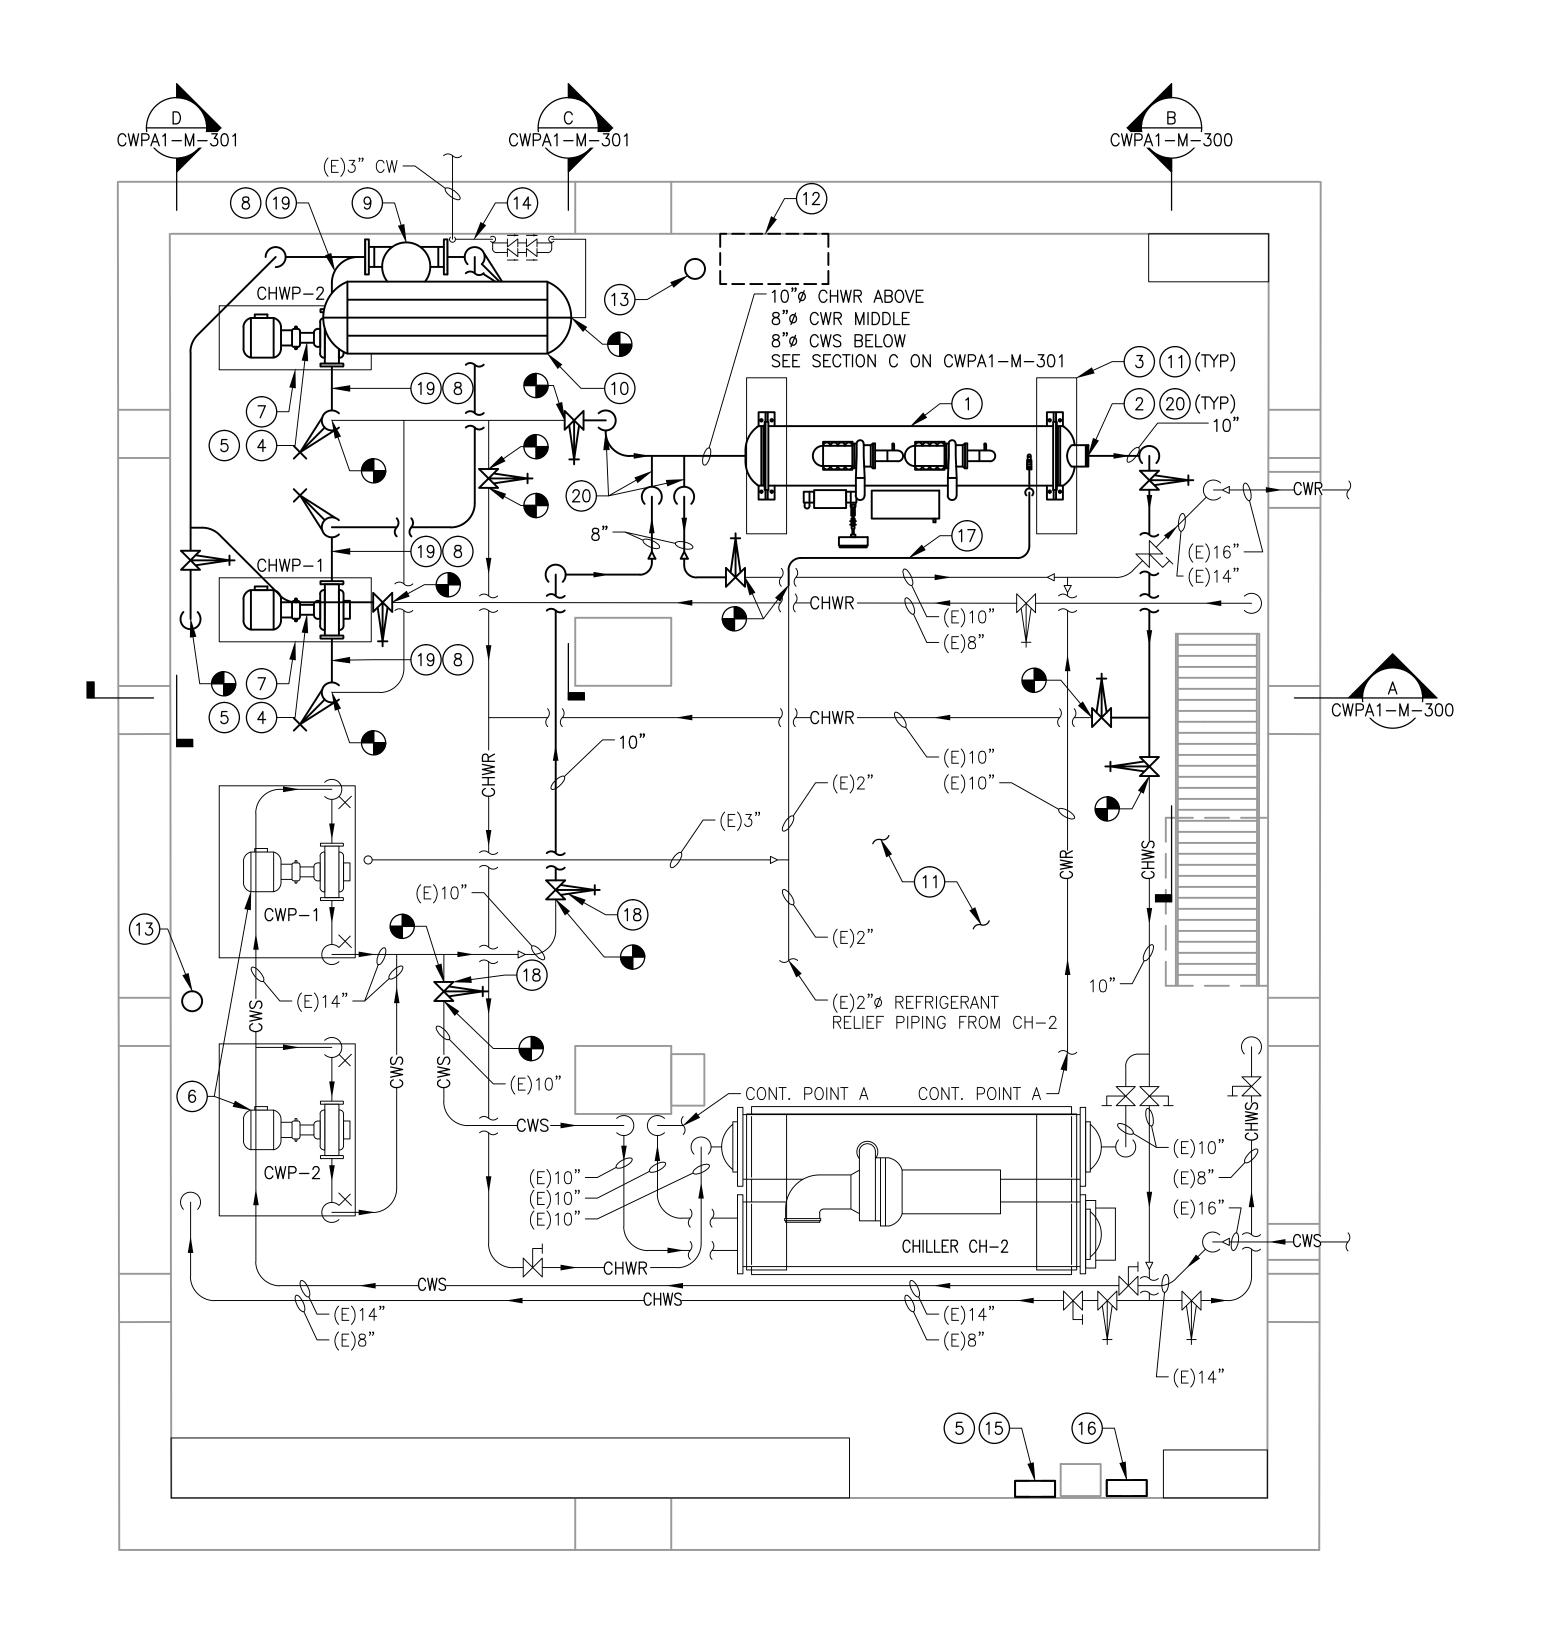

GENERAL NOTES:

- A. CONTRACTOR SHALL FIELD VERIFY AND COORDINATE LOCATION OF NEW EQUIPMENT, PIPING, VALVES, DUCTWORK, ELECTRICAL AND CONTROL WIRING WITH EXISTING PRIOR TO INSTALLATION. ITEMS SHOWN ON THIS PLAN ARE APPROXIMATE.
- B. REFER TO LEGEND SHEET FOR GENERAL ABBREVIATIONS AND SYMBOLS.

C. REFER TO CHILLER PIPING SCHEMATIC FOR ALL VALVES. ALL VALVES MAY NOT BE SHOWN ON THIS DRAWING FOR CLARITY.

D. INSTALL ALL EQUIPMENT AND COMPONENTS PER MANUFACTURERS RECOMMENDATION. PROVIDE ACCESS CLEARANCE AT ALL LOCATIONS OF VALVES, STRAINER, INSTRUMENTATION, AND EQUIPMENT AS REQUIRED BY MANUFACTURER AND FOR EASE OF MAINTENANCE.

KEYNOTES:

- (1) PROVIDE AND INSTALL CHILLER, CORRESPONDING VIBRATION ISOLATION, ANCHOR AND SUPPORT.
- (2) PROVIDE AND INSTALL ALL PIPING, FITTINGS, VALVES, PIPING INSULATION AND INSTRUMENTATION FOR CONNECTION TO CHILLER. PROVIDE A VICTAULIC COUPLING CONNECTION PIECE AT EACH PIPE CONNECTION TO CHILLER FOR EASE OF MAINTENANCE.
- (3) REUSE EXISTING EQUIPMENT PAD. REPAIR AND MODIFY AS REQUIRED TO FIT NEW INSTALLATION.
- (4) PROVIDE AND INSTALL CHILLED WATER PUMPS, CHWP-1 AND CHWP-2. INSTALLATION SHALL INCLUDE PUMP, INVERTER DUTY RATED MOTOR FOR VFD APPLICATION, VIBRATION SUPPORT, IMMEDIATE PIPING, ISOLATION VALVES, CHECK VALVES, STRAINER, FLEXIBLE CONNECTORS AND CORRESPONDING INSTRUMENTATION AND CONTROLS. INSULATE PUMPS AND PIPING.
- (5) INTEGRATE PUMP VFD DRIVES WITH CHILLER CONTROL PANEL. REFER TO ELECTRICAL DRAWINGS FOR EXACT LOCATION OF VFDs.
- (6) PROVIDE NEW INVERTER DUTY RATED MOTOR, COMPATIBLE WITH VFD, FOR CONDENSER WATER PUMPS CWP-1 AND CWP-2. REFER TO ELECTRICAL DRAWINGS FOR FURTHER INFORMATION
- (7) PROVIDE AND INSTALL NEW SPRING VIBRATION ISOLATION AND INERTIA PAD.
- (8) PROVIDE AND INSTALL ALL APPROPRIATE PIPE FITTINGS FOR CONNECTION TO PUMPS.
- (9) PROVIDE AND INSTALL AIR SEPARATOR, CORRESPONDING PIPING, AND SUPPORTS. INSULATE AIR SEPARATOR AND PIPING.
- (10) PROVIDE AND INSTALL EXPANSION TANK AND CORRESPONDING PIPING. REUSE EXISTING EXPANSION TANK SUPPORTS.
- (11) CONTRACTOR SHALL PAINT CHILLER PLANT FLOORS AND EQUIPMENT PADS WITH BATTLE SHIP GREY OR APPROVED EQUAL. SAFETY LINES AND TRIPPING HAZARDS SHALL BE PAINTED YELLOW OR RED.
- COORDINATE WITH OTHER WMATA CONTRACT INSTALLING WATER TREATMENT SYSTEM.
- B. PROVIDE AND INSTALL A NEW WMATA CHILLED WATER SYSTEM LOOP. THE LOOP SHALL INCLUDE PIPING, VALVES, HACH INDUCTIVE CONDUCTIVITY SENSOR - 3725E2T, FLOW SWITCH GEM SENSORS FS-500 170231, AND CONVERTIBLE DIGITAL pH SENSOR HACH DPC1R2A. REFER TO REFERENCE DRAWING DD-ME-HVAC-007.
- PROVIDE AND INSTALL A NEW WMATA CONDENSER WATER SYSTEM LOOP. THE LOOP SHALL INCLUDE PIPING. VALVES. HACH INDUCTIVE CONDUCTIVITY SENSOR - 3725E2T, FLOW SWITCH GEM SENSORS FS-500 170231. REFER TO REFERENCE DRAWING DD-ME-HVAC-008.

- (13) PROVIDE AND INSTALL CHEMICAL FEEDING POT FOR CHILLED WATER AND CONDENSER WATER SYSTEM. FEEDING POT SHALL BE NEPTUNE VTF-5HF.
- (14) 2" CHWR MAIN WITH A 1-1/4" BRANCH TO FCU-1.
- (15) PROVIDE AND INSTALL ONE CHILLER PLANT CONTROL PANEL (CPCP). REFER TO REFERENCE DRAWING DD-ME-HVAC-009 FOR CPCP DETAILS. PANEL SHALL BE INSTALLED 48" ABOVE FINISHED FLOOR.
- (16) PROVIDE AND INSTALL CHILLED WATER AND CONDENSER WATER FLOW MONITORING SYSTEM. PROVIDE AND INSTALL COMMUNICATIONS WIRING IN RIGID CONDUIT FROM FLOW MONITORING PANEL TO CHILLER PLANT CONTROL PANEL, UTILIZING BELDEN 89842 MULTI-CONDUCTOR; LOW CAPACITANCE TO COMPUTER POINT OF SERVICE (POS) CABLE OR EQUIVALENT. INSTALL 48" ABOVE FINISHED FLOOR. FLOW METER SHALL BE INSTALLED IN ACCORDANCE WITH MANUFACTURER'S RECOMMENDED INSTALLATION PROCEDURES. FLOW METERS AND SENSOR CABLES SHOULD NOT BE INSTALLED WITHIN EIGHT FEET OF VFDs OR FLORESCENT LIGHT FIXTURES.
- (17) PROVIDE AND INSTALL REFRIGERANT VENT/RELIEF PIPING FROM CHILLER (AS PER CHILLER MANUFACTURER). FIELD VERIFY AND CONNECT NEW 2" REFRIGERANT RELIEF PIPING FROM CHILLER TO EXISTING REFRIGERANT RELIEF MAIN.
- (18) PROVIDE AND INSTALL NEW CONDENSER WATER AND CHILLED WATER PIPING VALVES AS IDENTIFIED ON PLANS. EXACT QUANTITY OF VALVES SHALL BE FIELD VERIFIED BY INSTALLING CONTRACTOR.
- (19) PROVIDE 10" TO 8" SUCTION GUIDE WITH STRAINER, ANGLE FLANGE FOR 10" CHILLED WATER PIPING INLET INTO CHILLED WATER PUMP. PROVIDE A 6" TO 10" ANGLE FLANGE AT CHILLED WATER PUMP OUTLET FOR CONNECTION TO CHILLED WATER DISCHARGE PIPING.
- PROVIDE FLOOR MOUNTED PIPE SADDLE SUPPORT WITH BASE STAND AS NECESSARY FOR NEW PIPING. CHILLED WATER PIPING SUPPORTS SHALL BE PRE-INSULATED.



A Gannett Fleming/Parsons JOINT VENTURE

MECHANICAL PLAN - NEW WORK CWPA1-M-102

SCALE: 1/4" = 1'-0"

MANAGER, ENV. PLANNING AND COMP

WASHINGTON METROPOLITAN AREA TRANSIT AUTHORITY

DEPARTMENT OF DESIGN AND CONSTRUCTION SERVICES OFFICE OF INFRASTRUCTURE RENEWAL PROGRAM GROUP H Magnuser

03/2018 DATE GRAHAM SPILLER GFP DEPUTY PROGRAM MANAGER

REPLACEMENT OF CHILLERS AND COOLING TOWER ACCESSORIES AT EIGHT METRO-RAIL STATIONS CWPA1 - FARRAGUT NORTH (A02) **MECHANICAL PLAN - NEW WORK**

M NO. CONTRACT NO. SCALE DRAWING NO. SHEET NO. M1304 FQ-18102 1/4" = 1'-0" CWPA1-M-102 14 of 173

			REFERENCE DRAWINGS REVISIONS					WAS	
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